

ELEVATION-01

SCALE:

CLIENT
AklBeyti L.L.C.

DESIGNER
Zakaria Abdel Nabi

LOCATION
City hub mall Hawar Sports Club

DRAWING TITLE
ELEVATION

PROJECT NO. SCALE: 1:100 MTS.


DRAWING NO. E-01


GENERAL NOTES


1-ALL DIMENSIONS ARE IN M.


2-DESIN IS ACCORDING TO THE EGYPTION CODE


3-ALL MATERIALS SPECIFICATIONS ARE TO BE CONFORMED WITH PROJECT SPECIFICATIONS.

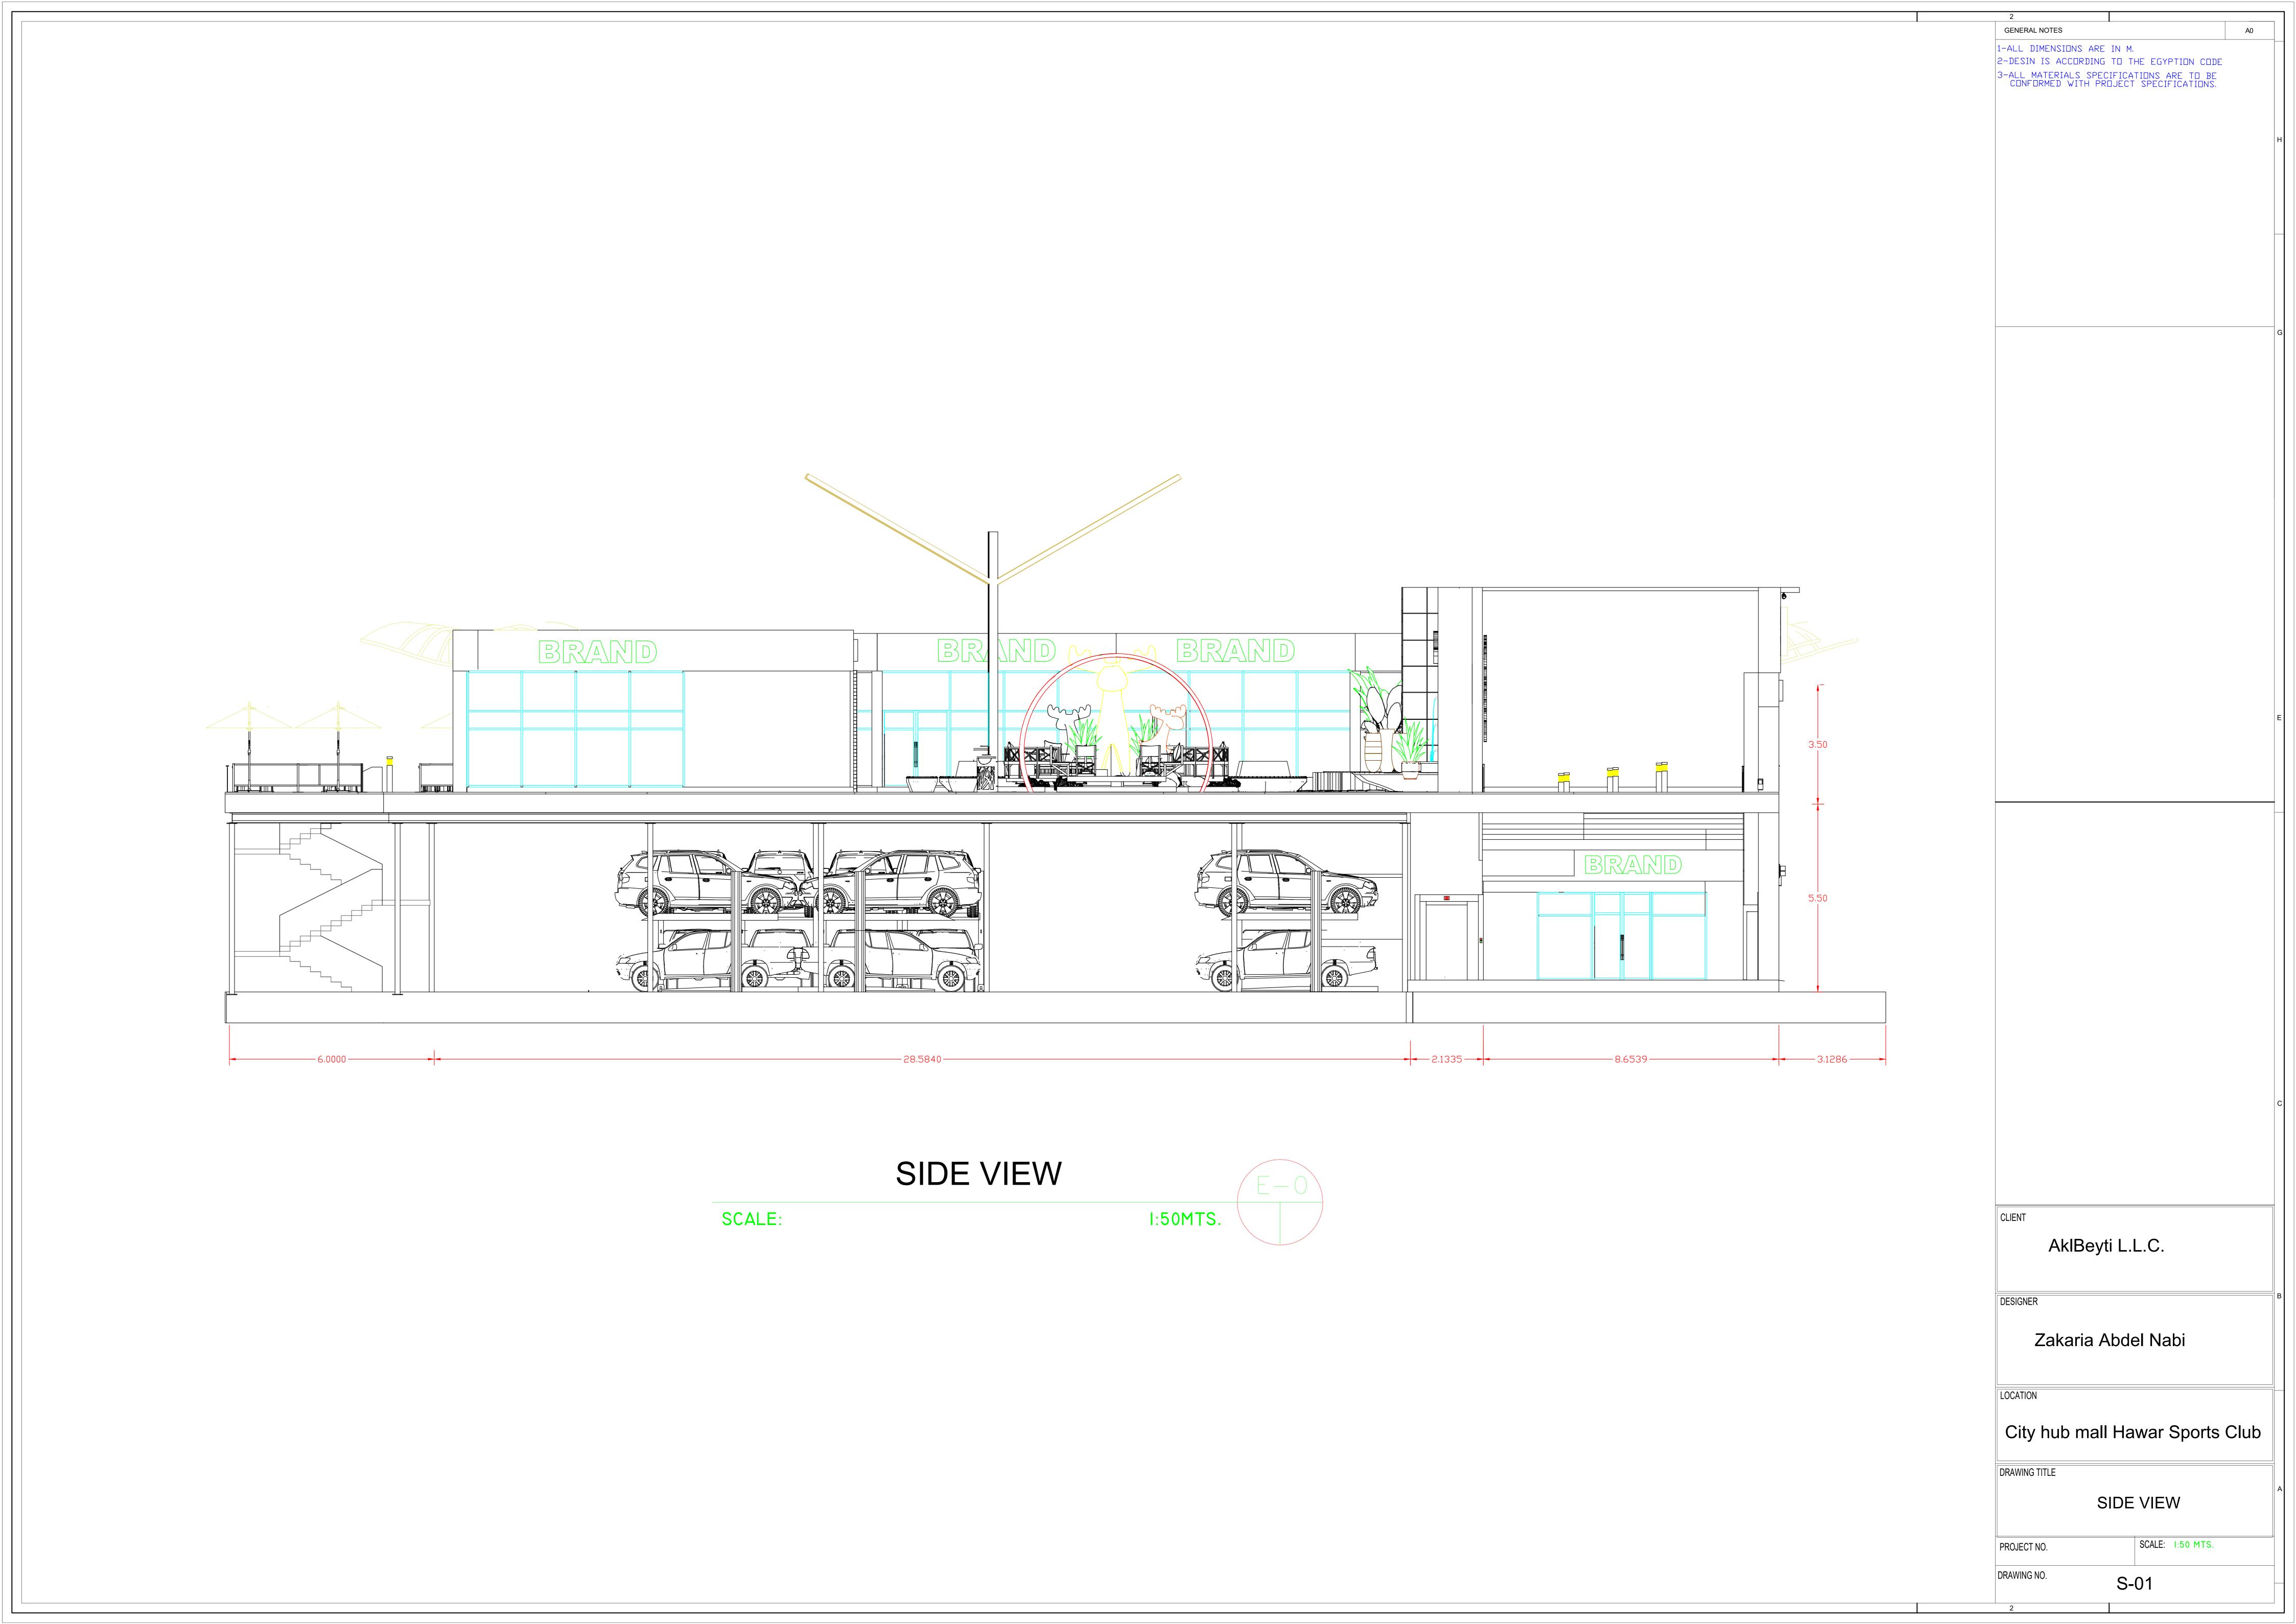


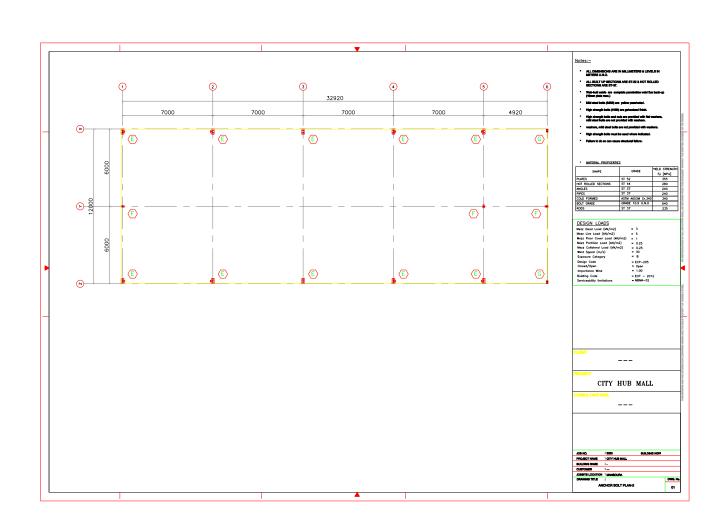


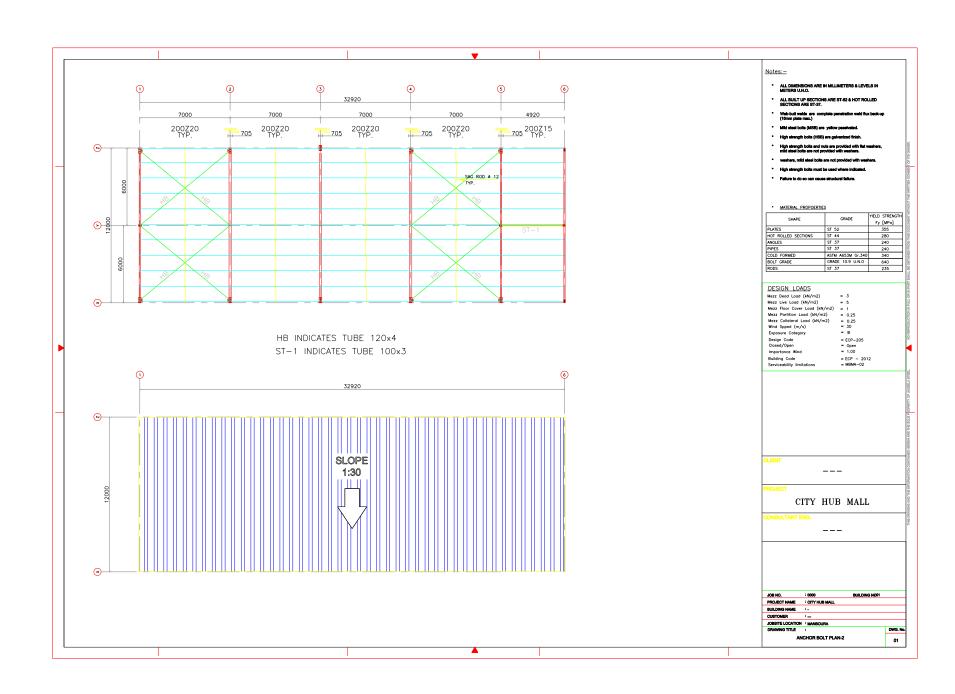


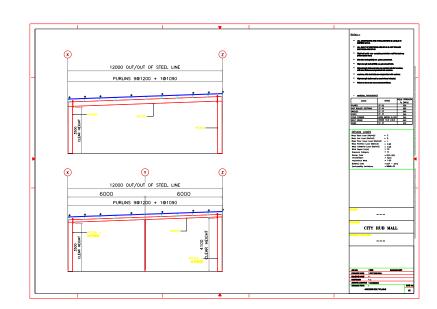


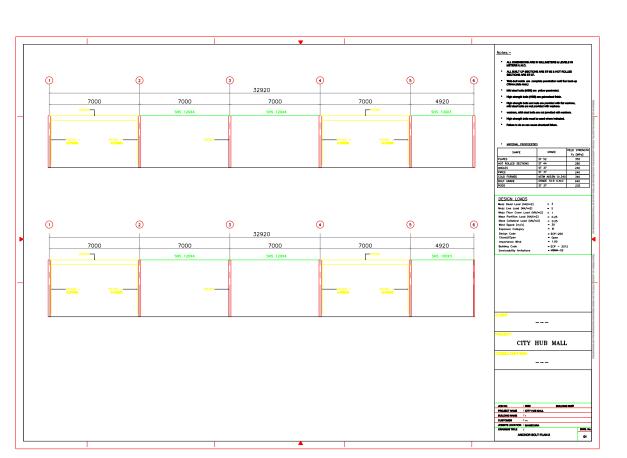


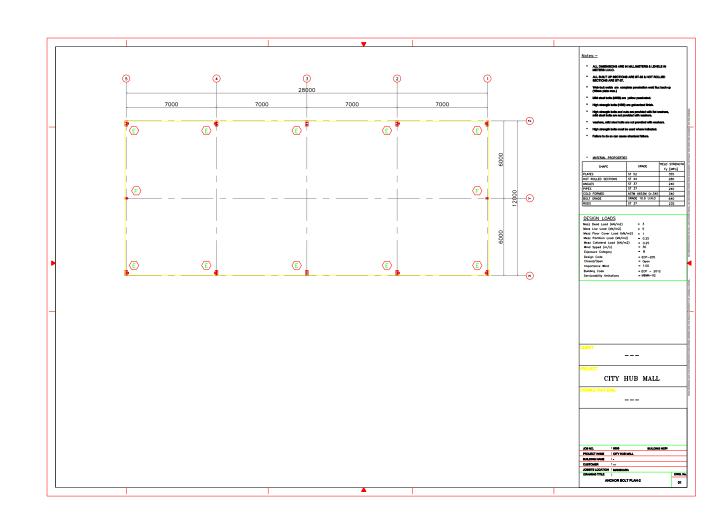


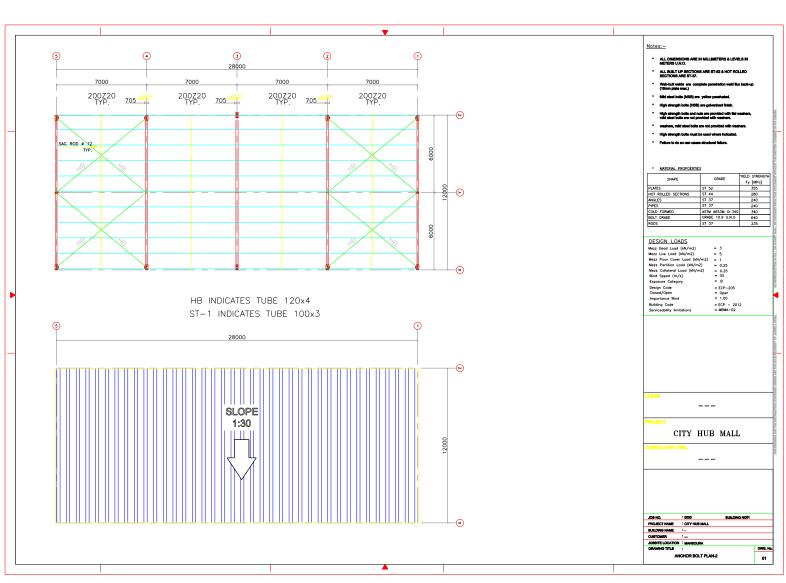


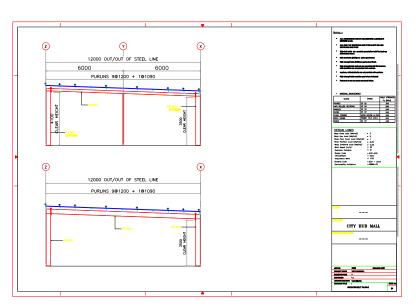

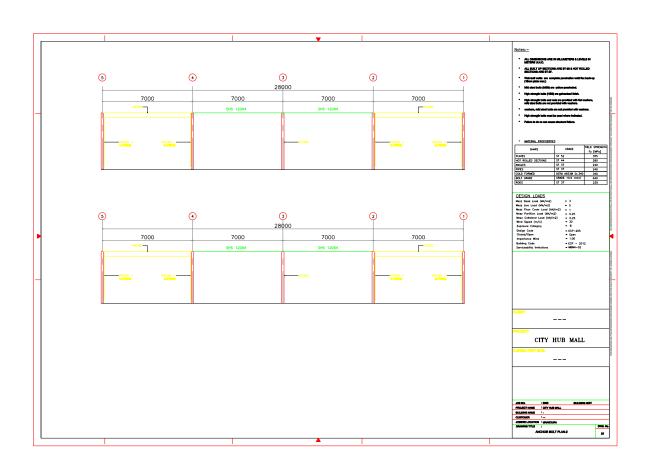

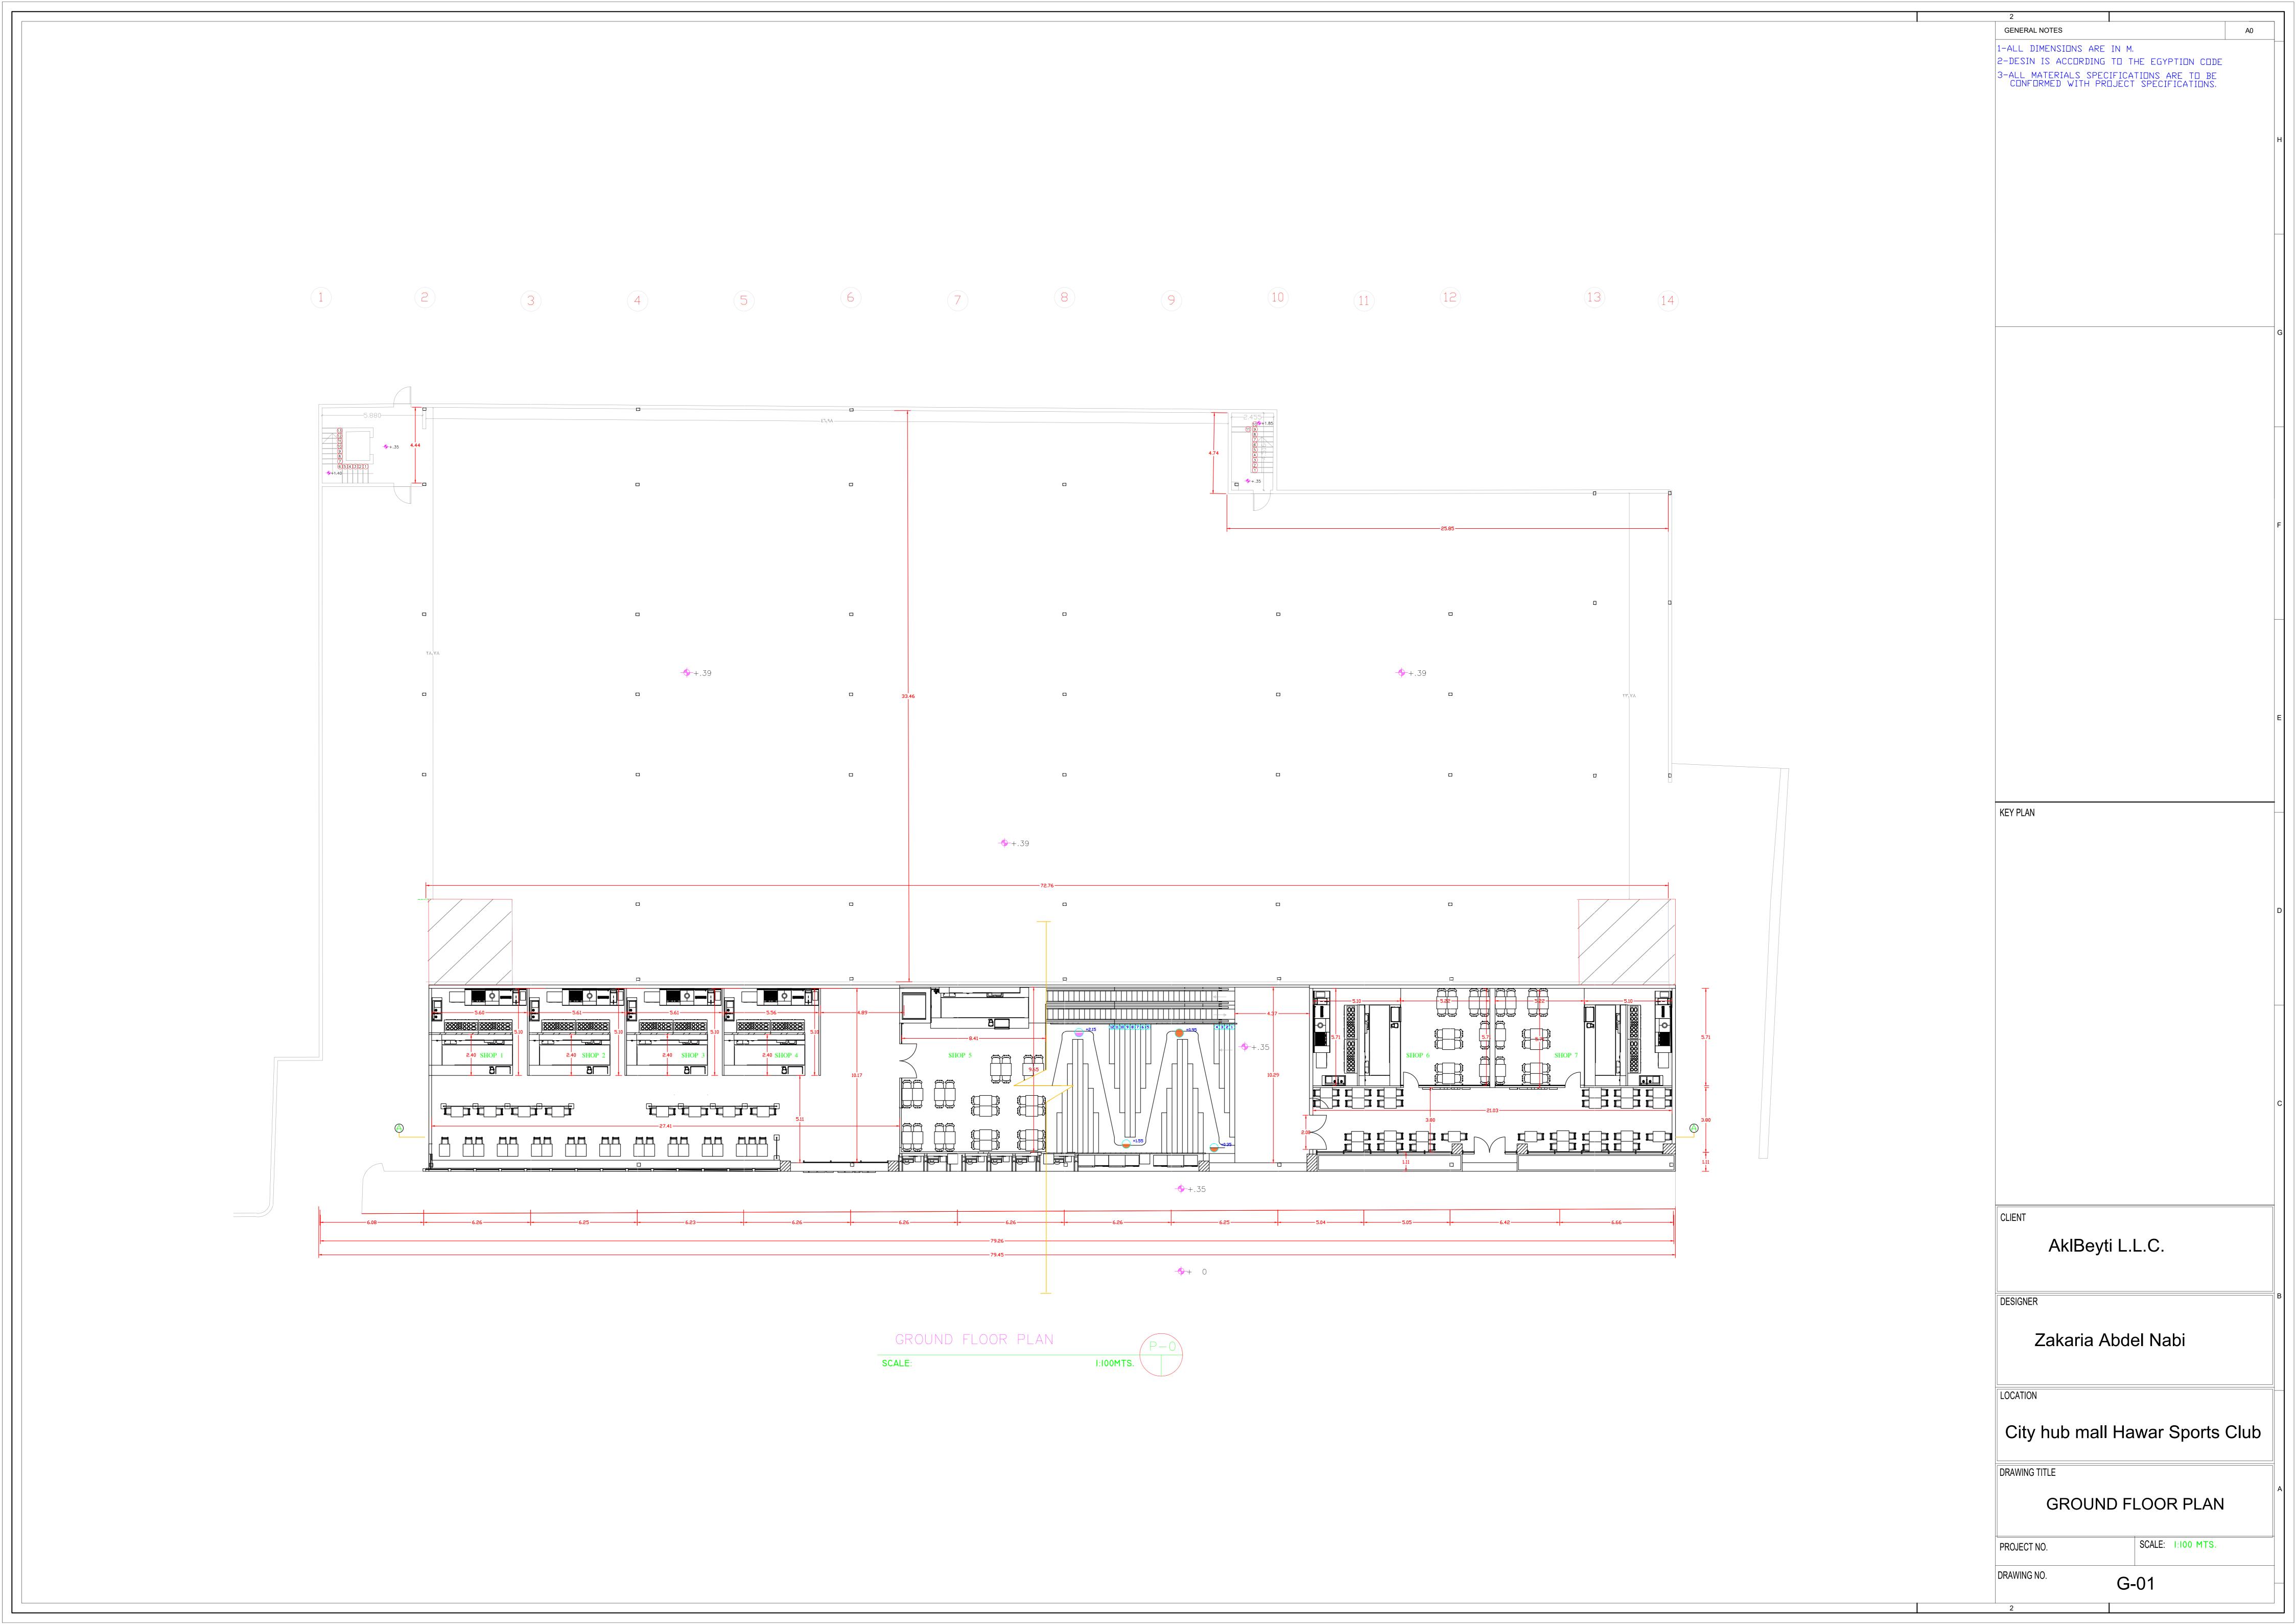

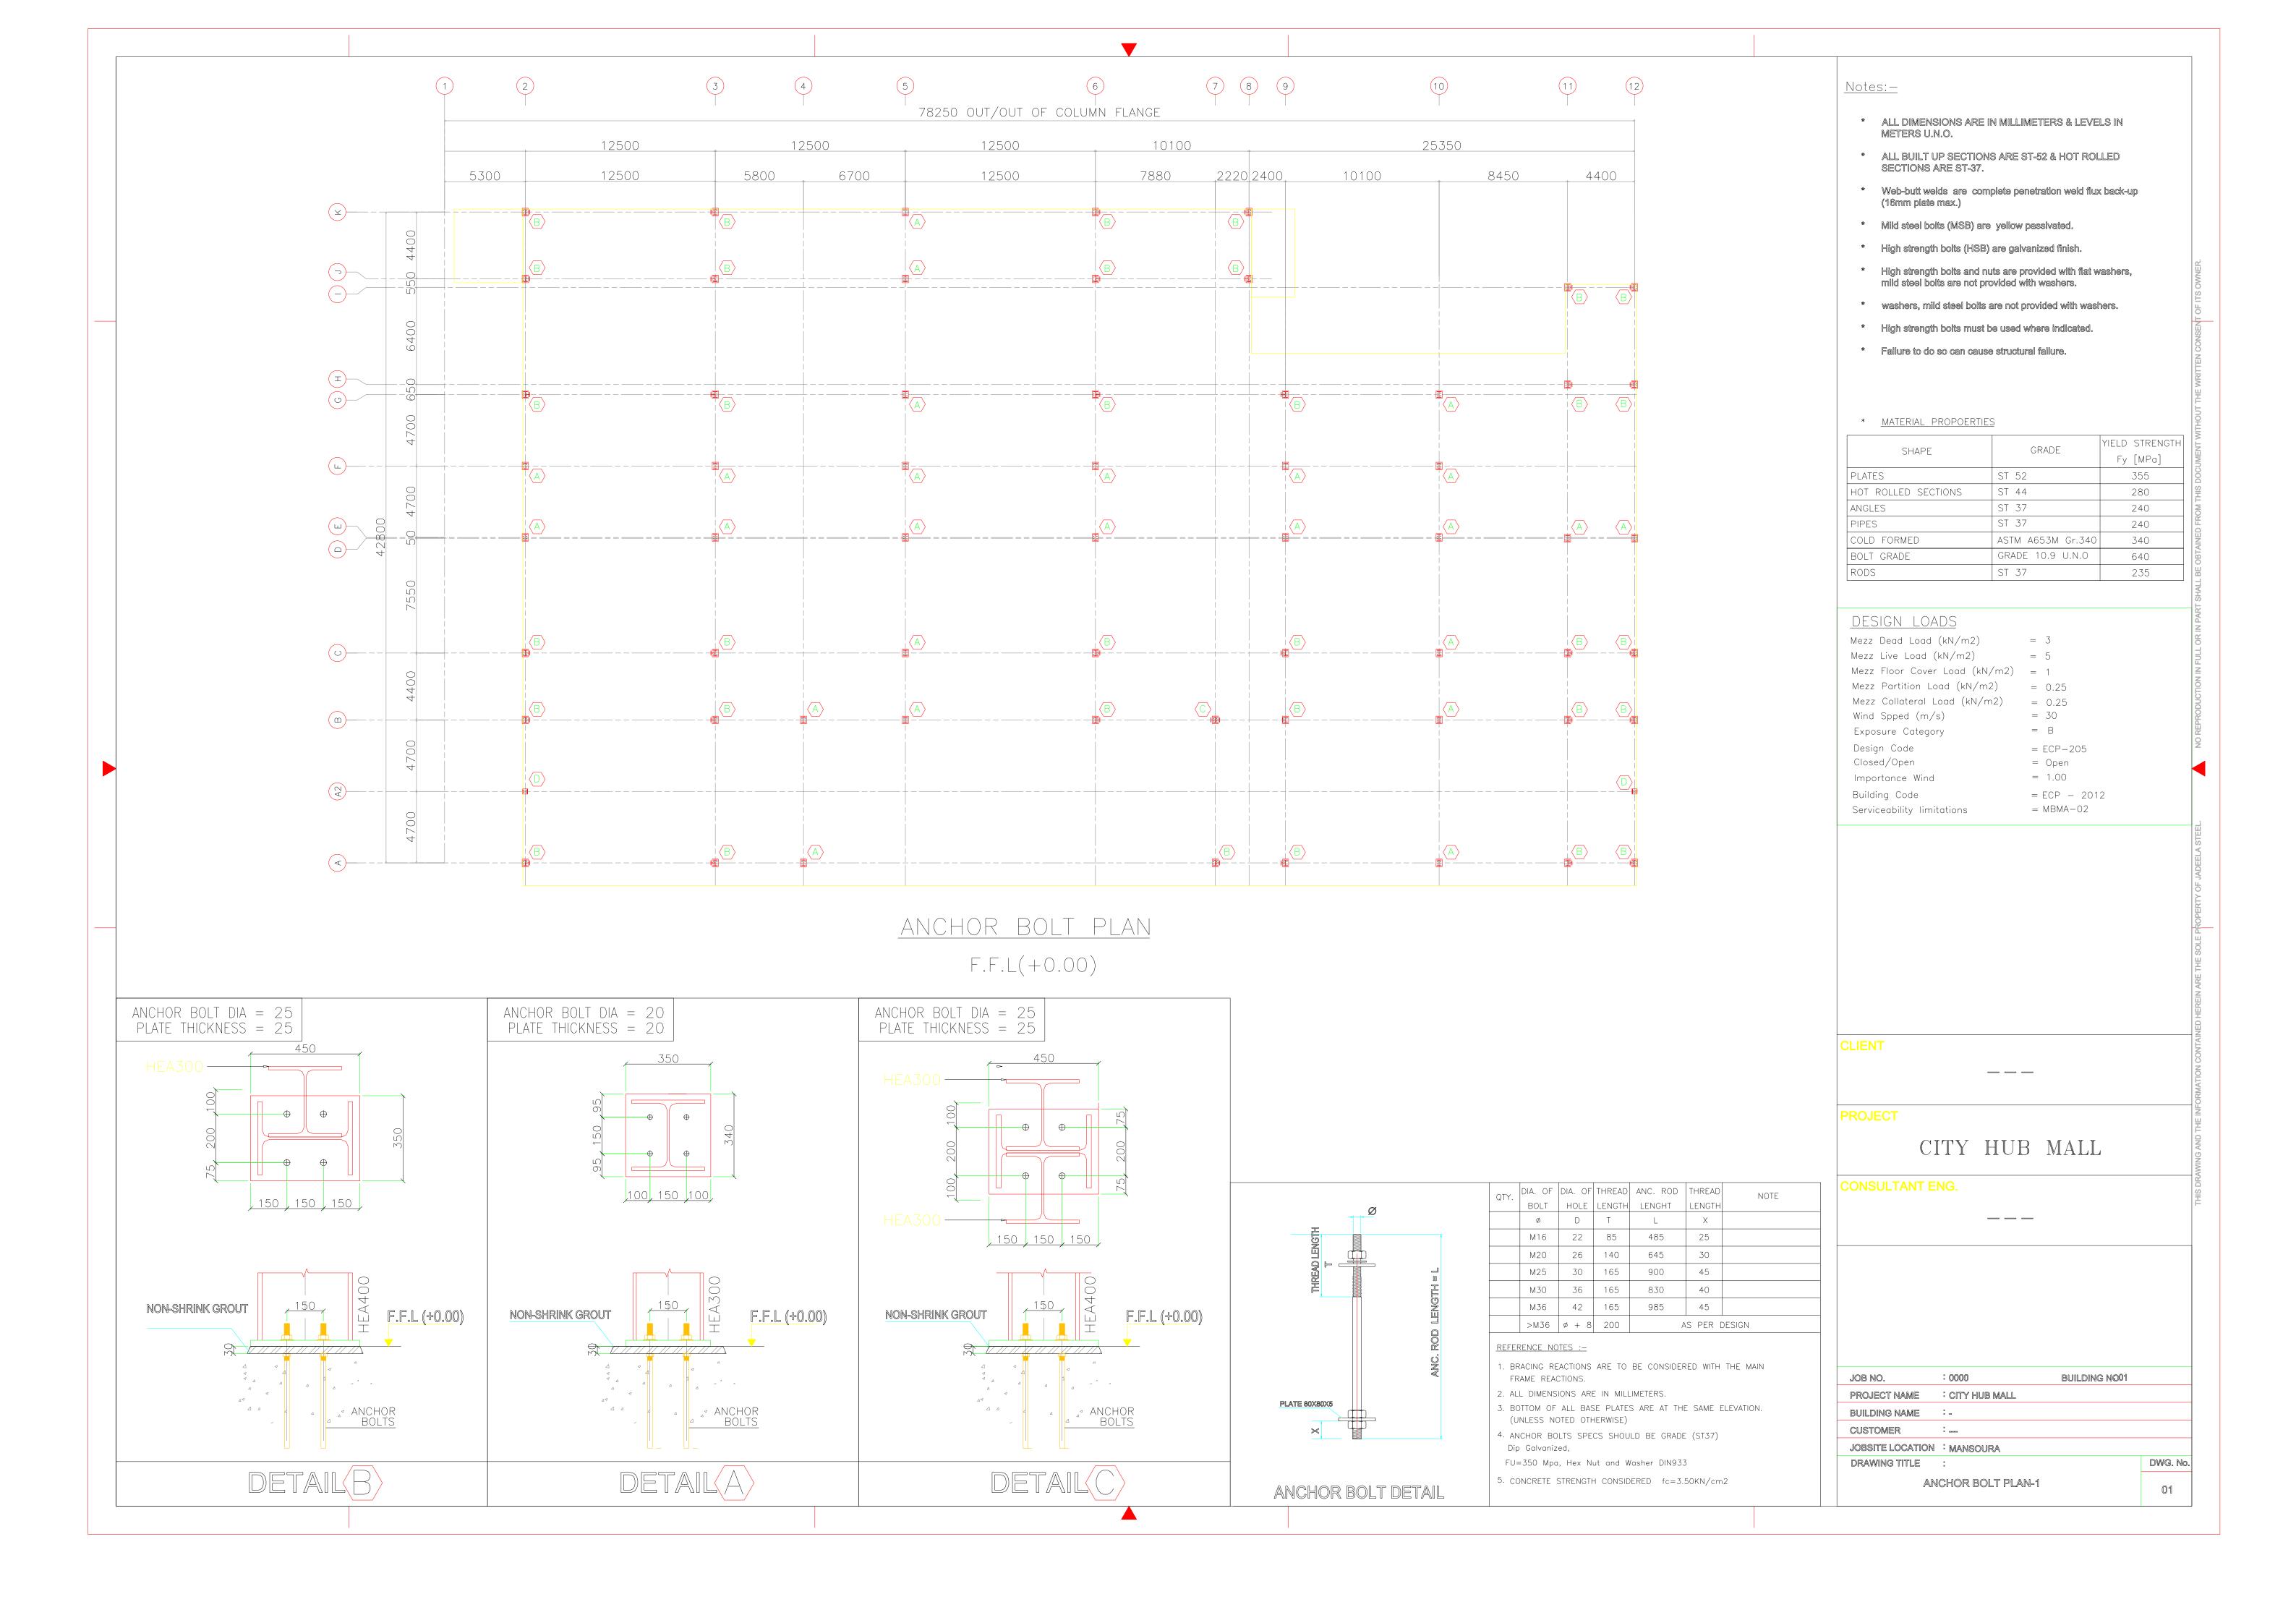

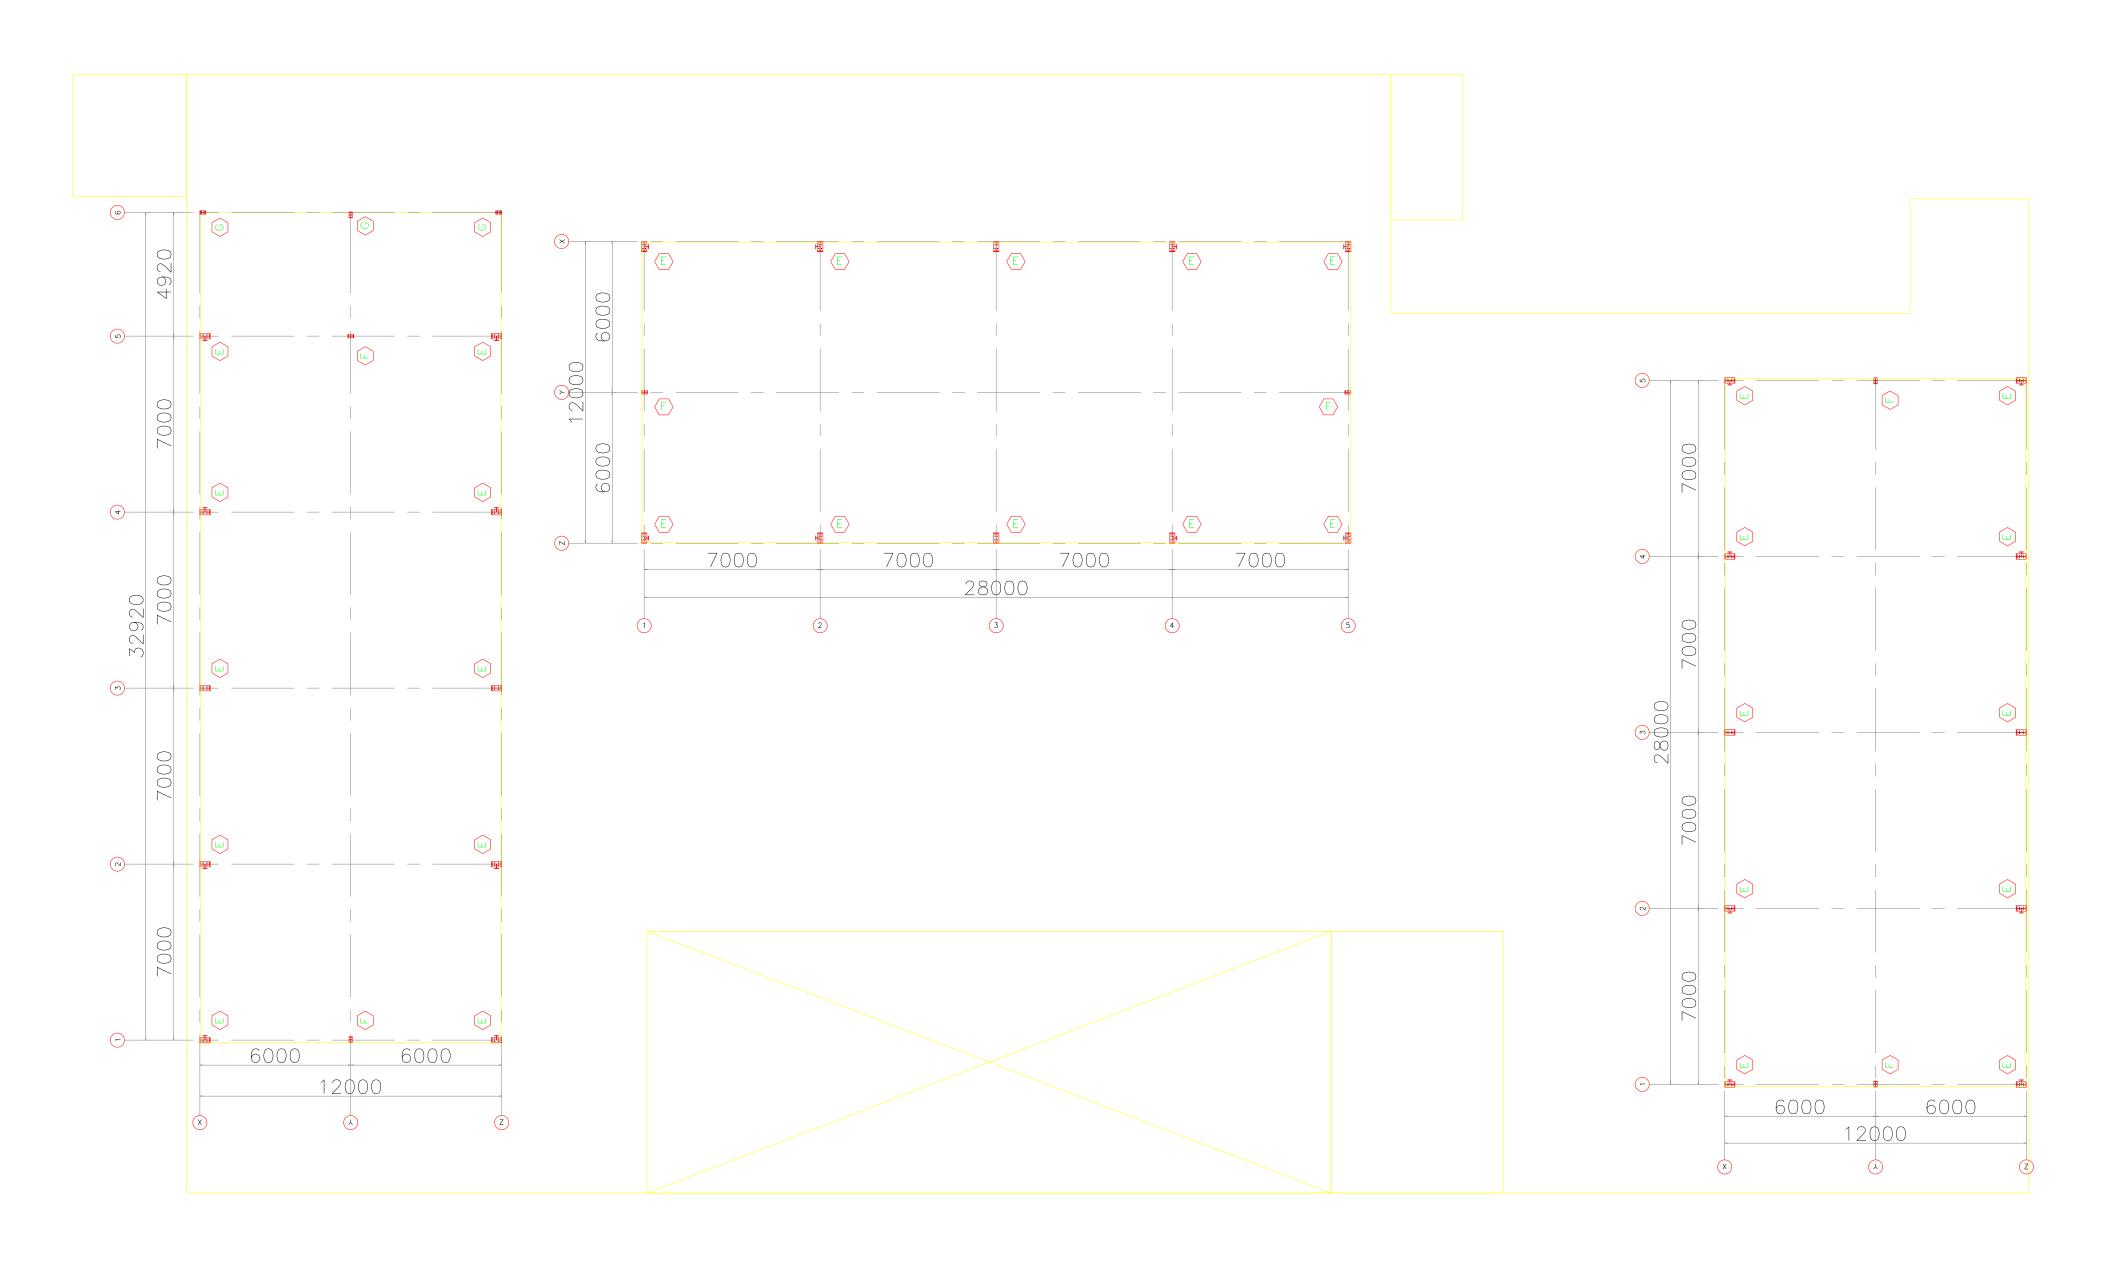

ANCHOR BOLT PLAN F.F.L(+5.75) <u>Notes:-</u>

- * ALL DIMENSIONS ARE IN MILLIMETERS & LEVELS IN METERS U.N.O.
- * ALL BUILT UP SECTIONS ARE ST-52 & HOT ROLLED SECTIONS ARE ST-37.
- Web-butt welds are complete penetration weld flux back-up (16mm plate max.)
- * Mild steel bolts (MSB) are yellow passivated.
- * High strength bolts (HSB) are galvanized finish.
- High strength bolts and nuts are provided with flat washers, mild steel bolts are not provided with washers.
- * washers, mild steel bolts are not provided with washers.
- * High strength bolts must be used where indicated.
- * Failure to do so can cause structural failure.

* <u>MATERIAL PROPOERTIES</u>

	CHADE	GRADE	YIELD STRENGTH
	SHAPE	GNADL	Fy [MPa]
	PLATES	ST 52	355
	HOT ROLLED SECTIONS	ST 44	280
	ANGLES	ST 37	240
	PIPES	ST 37	240
-	COLD FORMED	ASTM A653M Gr.340	340
	BOLT GRADE	GRADE 10.9 U.N.O	640
	RODS	ST 37	235
	PIPES COLD FORMED BOLT GRADE	ST 37 ASTM A653M Gr.340 GRADE 10.9 U.N.O	240 340 640

DESIGN LOADS Mezz Dead Load (kN/m2) = 3 Mezz Live Load (kN/m2) = 5 Mezz Floor Cover Load (kN/m2) = 1Mezz Partition Load (kN/m2) = 0.25 Mezz Collateral Load (kN/m2) = 0.25 Wind Spped (m/s) = 30 = B Exposure Category Design Code = ECP - 205Closed/Open = Open = 1.00 Importance Wind Building Code = ECP - 2012= MBMA-02Serviceability limitations

CLIEN

CITY HUB MALL

CONSULTANT ENG.

JOB NO. : 0000 BUILDING NO01

PROJECT NAME : CITY HUB MALL

BUILDING NAME : -

JOBSITE LOCATION : MANSOURA
DRAWING TITLE :


ANCHOR BOLT PLAN-2

1-2

DWG. No.

78250 OUT/OUT OF COLUMN FLANGE 12500 5300 10100 8450 4400 PB1 SB1 _____ ----SB1 SB1 SB1 SB1 SB1 SB1 SB1 SB1 SB1 PB2 - SB1- -SB1 SB1 SB1 SB1 SB1 SB1 SB1 SB1 SB1 SB3 SB2 SB1 SB1 SB1 SB2 SB3 — – – — – – SB1 – – - SB2--- - ----SB3--SB1 SB2 SB3 SB1 SB1 SB1 SB2 SB3 SB1 SB1 SB1 SB2 SB3 SB1 SB1 SB1 SB2 SB3 SB1 SB1 SB2 SB3 SB1 SB1 SB1 SB2 SB3 SB1 SB1 SB1 SB2 SB3 SB2 SB1 SB1 SB1 SB3 _____ SB1 SB1 SB1 SB2 SB3 SB2 SB3 SB1 SB1 SB1 SB2 SB3 SB1 SB1 SB1 SB1 SB2 SB3 \$B1 SB1 SB1 SB2 SB3 SB1 SB1 SB1 PB1 PB1 SB2 SB3 SB1 PB2 ____ ____ SB1 SB2 SB3 SB1 SB1 SB1 SB2 SB3 SB1 SB1 SB1 SB2 SB3 SB3 PB1 SB1 SB3 SB2 SB4 SB1 SB3 SB2 SB4 SB1 SB3 SB2 SB4 SB1 SB3 SB3 SB1 SB3 SB4 PB2 SB4 SB4 SB3 < SB4 SB4 SB4

> ROOF FRAMING PLAN T.O.S(+5.60)

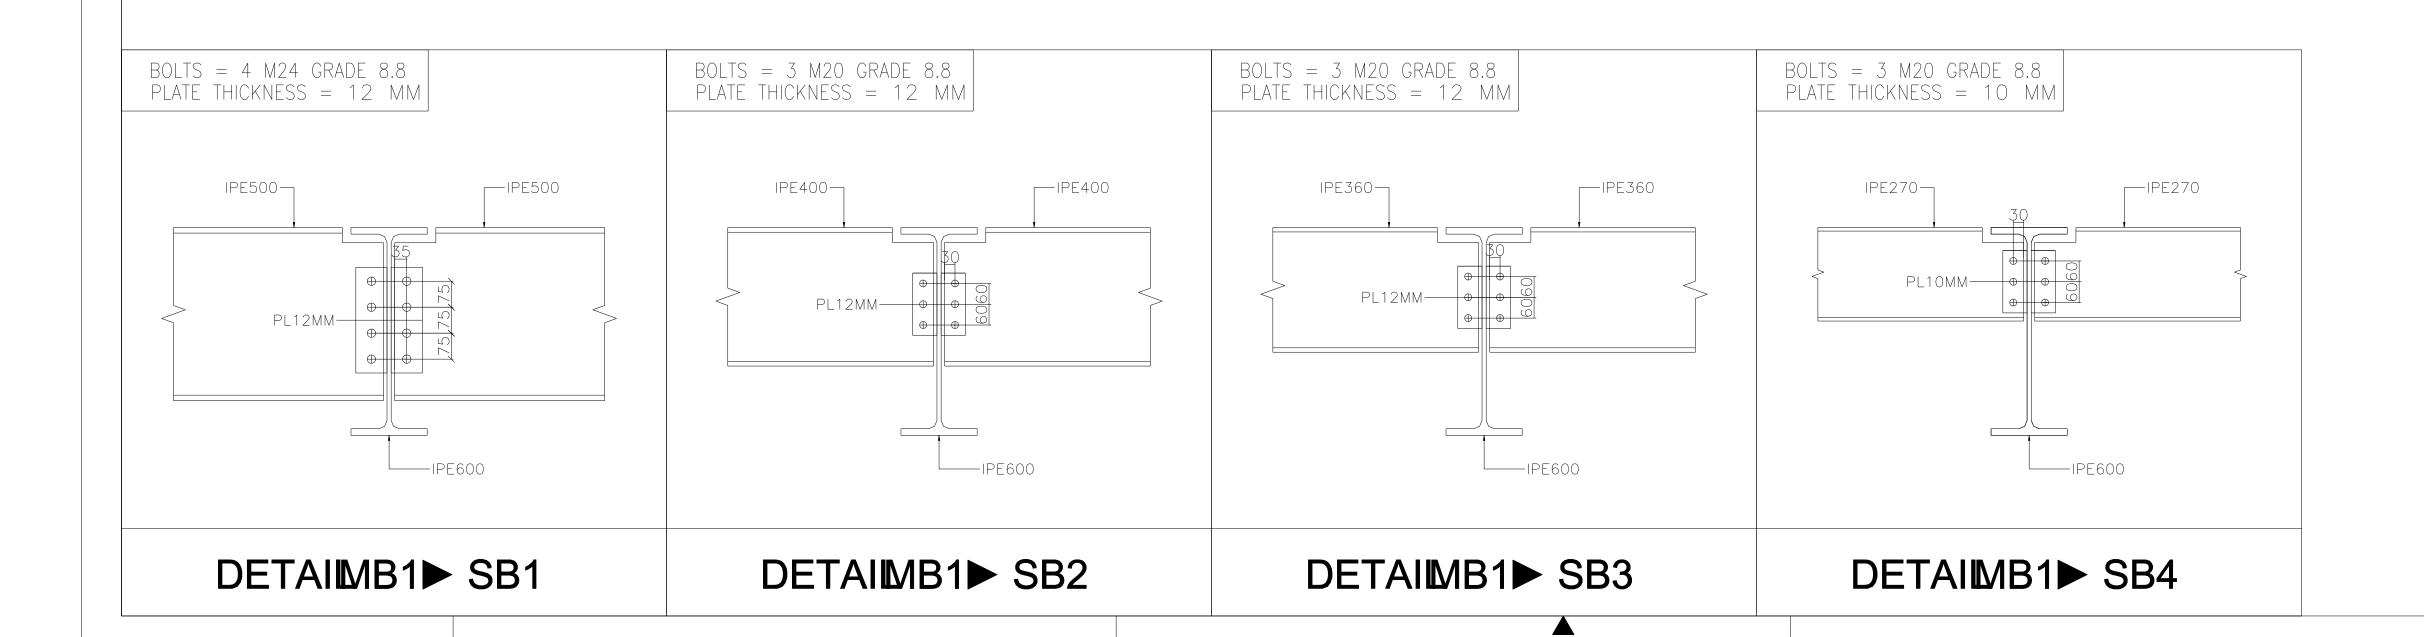

| Notes:

- * ALL DIMENSIONS ARE IN MILLIMETERS & LEVELS IN METERS U.N.O.
- * ALL BUILT UP SECTIONS ARE ST-52 & HOT ROLLED SECTIONS ARE ST-37.
- * Web-butt welds are complete penetration weld flux back-up (16mm plate max.)
- * Mild steel bolts (MSB) are yellow passivated.
- * High strength bolts (HSB) are galvanized finish.
- * High strength bolts and nuts are provided with flat washers, mild steel bolts are not provided with washers.
- * washers, mild steel bolts are not provided with washers.
- * High strength bolts must be used where indicated.
- * Failure to do so can cause structural failure.

* <u>MATERIAL PROPOERTIES</u>

SHAPF	GRADE	YIELD STRENGTH
SHAPE	GNADL	Fy [MPa]
PLATES	ST 52	355
HOT ROLLED SECTIONS	ST 44	280
ANGLES	ST 37	240
PIPES	ST 37	240
COLD FORMED	ASTM A653M Gr.340	340
BOLT GRADE	GRADE 10.9 U.N.O	640
RODS	ST 37	235

BEAMS TABLE

SN	NAME	PROFILE
1	PB1	HEA600
2	PB2	HEA400
3	MB1	IPE600
4	MB2	HEA600
5	SB1	IPE500
6	SB2	IPE400
7	SB3	IPE360
8	SB4	IPE270

CLIENT

PROJECT

CITY HUB MALL

CONSULTANT ENG.

DRAWING TITLE :

JOB NO.	: 0000	BUILDING NO01
PROJECT NAME	: CITY HUB MALL	
BUILDING NAME	:-	
CUSTOMER	:	
JOBSITE LOCATION	: MANSOURA	

ROOF FRAMING PLAN-1

02

DWG. No.